

UNIVERSITY OF SAINT JOSEPH:

PROGRESS SET - NOT FOR
CONSTRUCTION

RENOVATIONS & ADDITION TO LOURDES HALL

SCHEMATIC DESIGN PRICING SET

1678 ASYLUM AVENUE
WEST HARTFORD, CT 06117



01.16.2016

UNIVERSITY OF SAINT JOSEPH
1678 ASYLUM AVENUE
WEST HARTFORD, CT 06117

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GENERAL NOTES:

CALL BEFORE YOU DIG 1-800-922-4455: EXISTING UTILITIES HAVE BEEN PLOTTED BASED ON FIELD LOCATION OF VISIBLE STRUCTURES, LIMITED UTILITY MARKINGS PROVIDED BY OTHERS AND FROM OTHER AVAILABLE MAPS AND SOURCES. THE LOCATIONS ARE APPROXIMATE AND THERE MAY BE ADDITIONAL UTILITIES WITHIN THE PROJECT AREA. CONTRACTORS OR OTHERS USING THIS PLAN SHOULD VERIFY THE LOCATIONS OF ALL EXISTING UTILITIES WITHIN THE WORK AREA, NOTIFY EACH AFFECTED UTILITY COMPANY AND DIG TEST PITS AS REQUIRED PRIOR TO COMMENCING CONSTRUCTION. PORTIONS OF THE WATER, GAS AND ELECTRIC LINES WERE MARKED IN THE FIELD BY OTHERS. THE MARKINGS WERE FIELD LOCATED AND DEPICTED HEREON. IT IS NOT EVIDENT IN THE FIELD WHERE THE LINES MARKED COME FROM AND CONNECT TO.

FIELD TOPOGRAPHY IS LIMITED TO AREA IMMEDIATELY AROUND LOURDES HALL. OTHER TOPOGRAPHIC INFORMATION IS BASED ON PREVIOUS SURVEYS, AVAILABLE MAPPING OF THE CAMPUS AND OTHER SOURCES OF DATA. THE VERACITY AND CURRENT STATUS OF THIS INFORMATION IS NOT KNOWN. CONTRACTORS OR OTHERS USING THIS PLAN SHOULD VERIFY UTILITY LOCATIONS AND CHECK THE BENCHMARK(S) SHOWN ON THIS PLAN, PRIOR TO USE.

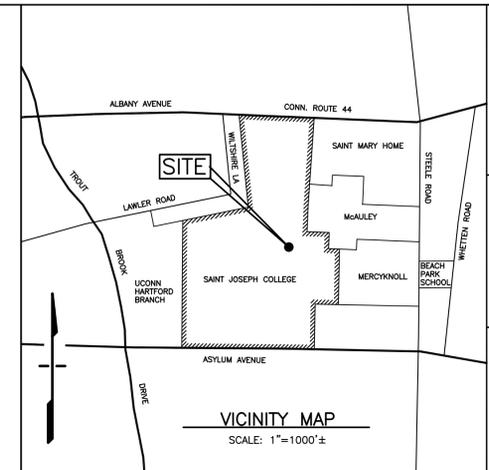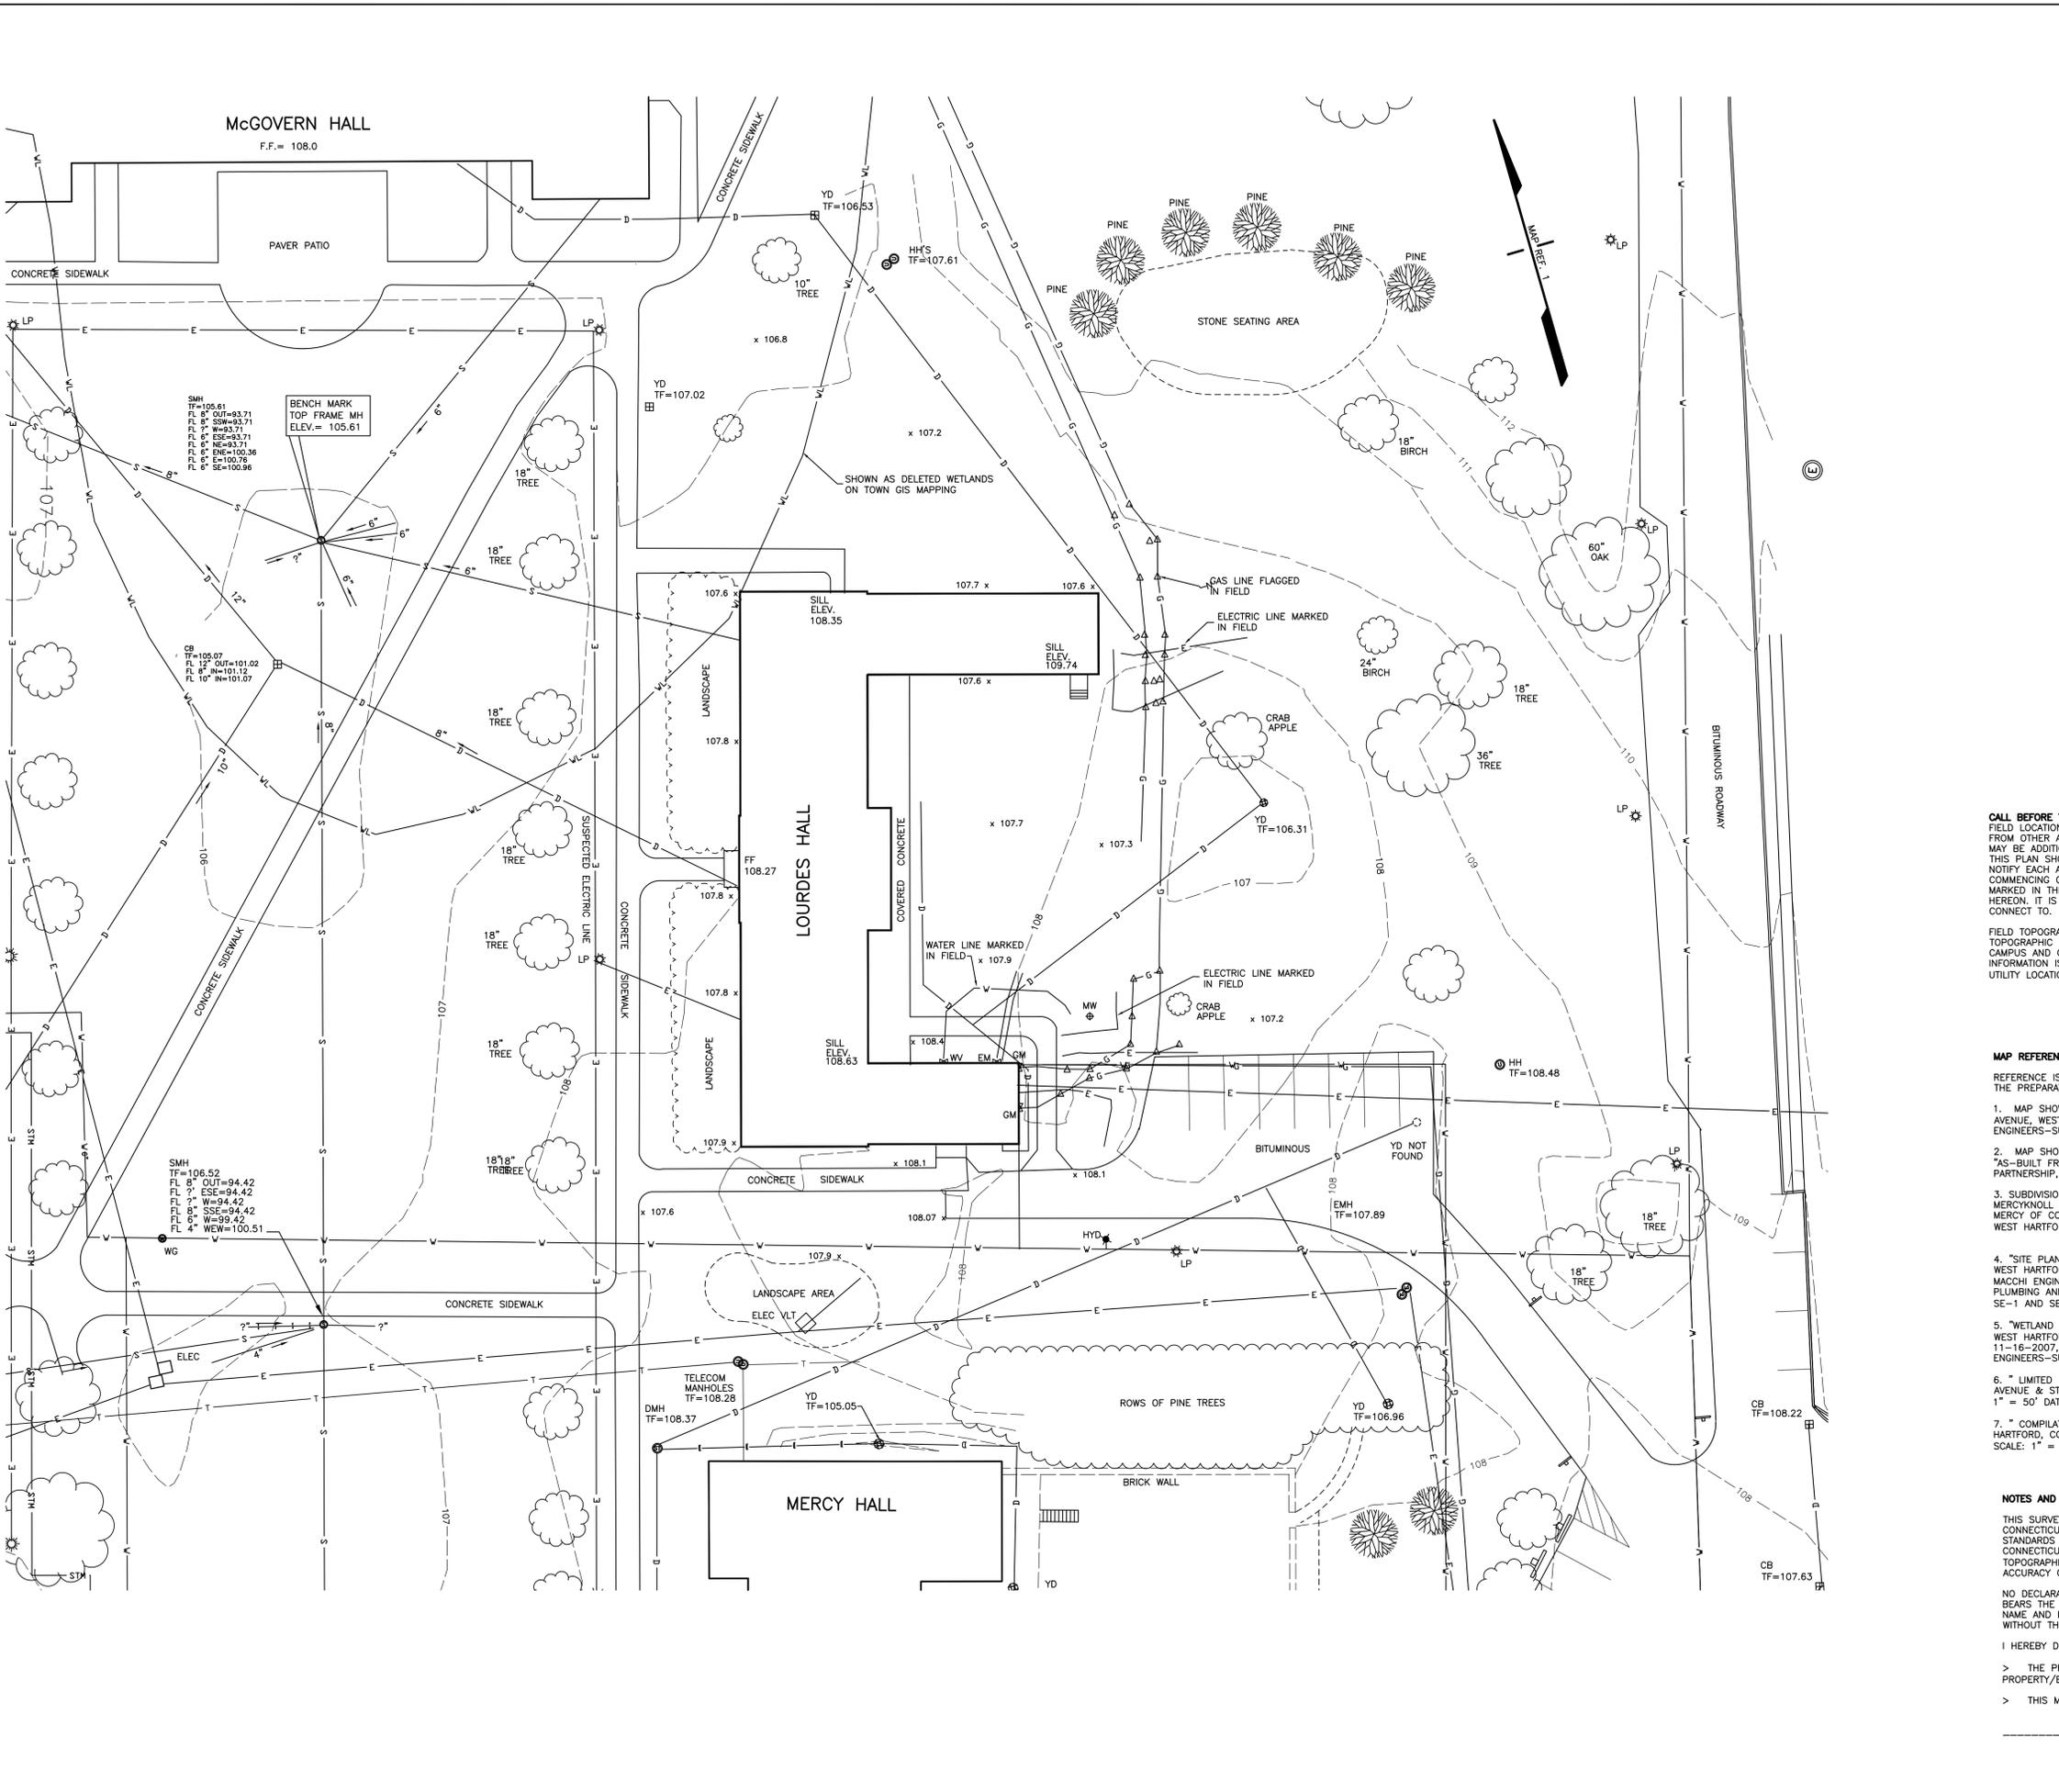MAP REFERENCES:

REFERENCE IS MADE TO THE FOLLOWING MAPS OR SURVEYS FROM WHICH DATA WAS USED IN THE PREPARATION OF THIS SURVEY AND MAP:

- MAP SHOWING BOUNDARY PLAN PREPARED FOR ST. JOSEPH COLLEGE, 1678 ASYLUM AVENUE, WEST HARTFORD, CT. DATE: 4-20-1992 SCALE: 1" = 100', BY MEEHAN & GOODIN ENGINEERS-SURVEYORS, P.C. 387 NORTH MAIN STREET, MANCHESTER, CT.
- MAP SHOWING SITE PLAN-UTILITIES AND EROSION CONTROL DRAWING NUMBER C-2, "AS-BUILT FROM N.C.I.", DATE: SEPT. 14, 2000 SCALE: 1" = 40', BY THE GEDDIS PARTNERSHIP, ARCHITECTURE PLANNING INTERIORS, 2023 SUMMER STREET, STAMFORD, CT.
- SUBDIVISION PROPERTY OF SAINT JOSEPH COLLEGE, SAINT MARY HOME INCORPORATED, MERCYKNOLL INCORPORATED, A PORTION OF WHICH IS TO BE CONVEYED TO THE SISTERS OF MERCY OF CONNECTICUT INCORPORATED ALBANY AVENUE, STEELE ROAD, ASYLUM AVENUE, WEST HARTFORD, CT. SCALE: 1" = 100' DATE: JULY 22, 1982 BY: CLOSE, JENSEN & MILLER.
- "SITE PLAN OF RESIDENCE HALLS FOR SAINT JOSEPH COLLEGE 1678 ASYLUM AVENUE WEST HARTFORD, CT. DATE: DEC. 3, 2007 REVISED FEB. 8, 2008 SCALE AS NOTED BY MACCHI ENGINEERING CIVIL/STRUCTURAL, BEMIS ASSOCIATES, LLC MECHANICAL, ELECTRICAL PLUMBING AND FIRE PROTECTION, JCY ARCHITECTURE, INC SHEETS: C-2.0 THUR 2.5 AND SE-1 AND SE-2."
- "WETLAND MAP AMENDMENT PLAN FOR SAINT JOSEPH COLLEGE 1678 ASYLUM AVENUE WEST HARTFORD, CT. SCALE: 1" = 40' DATE: 10-19-2007 REVISED: 10-22-2007, 11-16-2007, 11-20-2007 SHEET 10F.2 AND 2 OF 2 BY: MEEHAN & GOODIN ENGINEERS-SURVEYORS, P.C. 387 NORTH MAIN STREET, MANCHESTER, CT.
- "LIMITED PROPERTY SURVEY FOR LAND OF SAINT MARY HOME INCORPORATED ALBANY AVENUE & STEELE ROAD TOWN OF WEST HARTFORD, HARTFORD COUNTY, CONNECTICUT SCALE: 1" = 50' DATE: 09-28-2012, BY: CLARENCE BLAIR ASSOCIATES, INC."
- "COMPILATION PLAN, OVERALL CAMPUS PLAN MERCY COMMUNITY HEALTH IN WEST HARTFORD, CONNECTICUT DATE: DEC. 11, 2007, REVISED TO 2-22-08, 4-04-08, 4-22-08, SCALE: 1" = 100' BY: ARCH CONSULTS, LTD."

NOTES AND DECLARATIONS:

THIS SURVEY AND MAP HAS BEEN PREPARED IN ACCORDANCE WITH THE REGULATIONS OF CONNECTICUT STATE AGENCIES, SECTIONS 20-300B-1 THRU 20-300B-20, THE MINIMUM STANDARDS FOR SURVEYS AND MAPS IN THE STATE OF CONNECTICUT ENDORSED BY THE CONNECTICUT ASSOCIATION OF LAND SURVEYORS, INC. THE TYPE OF SURVEY IS TOPOGRAPHIC, THE BOUNDARY DETERMINATION CATEGORY IS N/A, AND THE VERTICAL ACCURACY CONFORMS TO T-2.

NO DECLARATION IS EXPRESSED OR IMPLIED BY THIS MAP OR COPIES THEREOF UNLESS IT BEARS THE IMPRESSION TYPE SEAL AND ORIGINAL LIVE SIGNATURE OF THE SURVEYOR WHOSE NAME AND REGISTRATION NUMBER APPEAR BELOW. ANY CHANGES MADE TO THIS PLAN WITHOUT THE KNOWLEDGE OF THE SIGNERS INVALIDATES THESE DECLARATIONS.

I HEREBY DECLARE THAT TO THE BEST OF MY KNOWLEDGE, INFORMATION AND BELIEF:

- > THE PROPERTY LINES DEPICTED HEREON DO NOT REPRESENT THE SURVEYOR'S PROPERTY/BOUNDARY OPINION.
- > THIS MAP IS SUBSTANTIALLY CORRECT AS NOTED HEREON.

REVISION	DATE
	12-23-2003

PLAN PREPARED FOR: **SAINT JOSEPH COLLEGE**
WEST HARTFORD CONN.
1678 ASYLUM AVENUE
DESIGN: RED
DRAFT: FS
DATE: 1-12-2016
SCALE: 1" = 20'

TOPOGRAPHIC SURVEY
SHEET NO. 1 OF 1
DATE: 1-12-2016
SCALE: 1" = 20'

UNIVERSITY OF SAINT JOSEPH
 RENOVATIONS & ADDITION TO LOURDES HALL
 1678 ASYLUM AVENUE
 WEST HARTFORD, CT 06117

CONSULTANTS

KEY PLAN

PROGRESS SET - NOT FOR CONSTRUCTION

PROJECT DATA		
PROJECT NUMBER	15098	
CURRENT SUBMISSION DATE	01.16.2016	
DRAWN	JMM	
CHECKED	JMM	
SCALE	As Indicated	
FILE REFERENCE	C:\Users\rha\Documents\15098-St. Joseph College Lourdes Hall Renovations-Central 2016-SD_Option2-Single-Roof_RHA.rvt	
HISTORY OF SUBMISSIONS		
No.	Date	Description

SCHEMATIC DESIGN
 PRICING SET

SHEET TITLE

GRAPHICS LEGEND,
 ABBREVIATIONS, SYMBOL
 LEGEND

G1.01.

A 1.01	SHEET NUMBER
	Sheet Number Sequence
	Sheet Type
	Discipline
	ENLARGED PLAN / DETAIL IDENTIFICATION
	Detail Number
	Sheet Number
	SECTION IDENTIFICATION
	Detail Number
	Sheet Number
	EXTERIOR ELEVATION IDENTIFICATION
	Elevation Number
	Sheet Number
	INTERIOR ELEVATION IDENTIFICATION
	Elevation Number
	Sheet Number
	DIMENSION TO CENTERLINE
	DIMENSION LINE
	EXISTING CONSTRUCTION TO REMAIN
	EXISTING CONSTRUCTION TO BE REMOVED
	NEW CONSTRUCTION
	CENTERLINE
	DOOR NUMBER
	WINDOW NUMBER
	PARTITION TYPE
	ROOM NAME / NUMBER
	ROOM AREA (IF DISPLAYED)
	CEILING HEIGHT
	VERTICAL ELEVATION
	SPOT ELEVATION
	ROOF PITCH
	KEYED NOTE
	MATERIAL NOTE
	FURNITURE TAG
	NORTH ARROW
	DRAWING REVISION / REVISION NUMBER
	COLUMN GRID TAG
	ACCESSIBLE ELEMENT
	CLEAR FLOOR SPACES FOR WHEELCHAIR: 2'-6" x 4'-0" AND 5'-0" DIAMETER
	20 R @ 7 1/2"
	DIRECTION OF DOWNWARD SLOPE
	ROOM FINISH TAG
	WALL FINISH TAG
	FINISH TRANSITION TAG
	SEMI RECESSED FIRE EXTINGUISHER

(E)	EXISTING	JAN	JANITOR
(N)	NEW	JC	JANITOR'S CLOSET
(R)	RELOCATED	L	LABORATORY
A:	-----	LAM	LAMINATE
AC	AIR CONDITIONING	LAV	LAVATORY
ACC	ACCESSIBLE	LB	POUND
ACT	ACOUSTICAL CEILING TILE	LF	LINEAR FOOT
ADD	ADDITIONAL	LLH	LONG LEG HORIZONTAL
ADJ	ADJUSTABLE	LLV	LONG LEG VERTICAL
AFF	ABOVE FINISH FLOOR	M	MACHINE
ALT	ALTERNATE	MACH	MACHINE
ALUM	ALUMINUM	MAINT	MAINTENANCE
APPROX	APPROXIMATE	MATL	MATERIAL
ARCH	ARCHITECTURAL	MAX	MAXIMUM
AV	AUDIO VISUAL	MBL	MARBLE
B	BOARD	MDF	MEDIUM DENSITY FIBERBOARD
BD	BOARD	MDO	MEDIUM DENSITY OVERLAY PLYWOOD
BLDG	BUILDING	MECH	MECHANICAL
BO	BOTTOM OF	MEP	MECHANICAL, ELECTRICAL, PLUMBING
BUR	BUILT-UP ROOFING	MEZZ	MEZZANINE
C	-----	MFR	MANUFACTURER
CB	CATCH BASIN	MH	MANHOLE
CG	CORNER GUARD	MH	MANHOLE
CIP	CAST-IN-PLACE	MISC	MISCELLANEOUS
CJ	CONTROL / CONSTRUCTION JOINT	MM	MILLIMETER
CL	CENTER LINE	MO	MASONRY OPENING
CLG	CEILING	MTD	MOUNTED
CLR	CLEAR	MTG	MOUNTING
CMU	CONCRETE MASONRY UNIT	N	-----
CO	CLEANOUT	NA	NOT APPLICABLE
COL	COLUMN	NC	NOISE CRITERIA
CONC	CONCRETE	NIC	NOT IN CONTACT
CONT	CONTINUOUS	NOM	NOMINAL
COORD	COORDINATE	NTS	NOT TO SCALE
CORR	CORRIDOR	O	ON CENTER
CT	CERAMIC TILE	OC	OUTSIDE
CW	COLD WATER	OD	OWNER FURNISHED, CONTR INSTALLED
D	-----	OFCI	OWNER FURNISHED, OWNER INSTALLED
DEMO	DEMOLITION	OFOI	OWNER FURNISHED, OWNER INSTALLED
DEPT	DEPARTMENT	OPP	OPPOSITE
DF	DRINKING FOUNTAIN	ORD	OVERFLOW ROOF DRAIN
DIA	DIAMETER	OVHD	OVERHEAD
DIM	DIMENSION	P	PAINT
DISP	DISPENSER	PBD	PARTICLEBOARD
DN	DOWN	PC	PRECAST CONCRETE
DO	DOOR OPENING	PERF	PERFORATED
DP	DOOR OPENING POINT	PERM	PERIMETER
DR	DOOR	PERP	PERPENDICULAR
DS	DOWNSPOUT	PL	PLATE
DW	DISHWASHER	PLM	PLASTIC LAMINATE
DWG	DRAWING	PLF	POUNDS PER LINEAR FOOT
E	-----	PR	PAIR
EA	EACH	PREFAB	PREFABRICATED
EFS	EXTERIOR INSULATION & FINISH SYSTEM	PROJ	PROJECT
EIFS	EXTERIOR FINISH SYSTEM	PSF	POUNDS PER SQUARE FOOT
EJ	EXPANSION JOINT	PT	POINT
EL	ELEVATION	PTD	PAINTED
ELECT	ELECTRICAL	Q	QUARRY TILE
ELEV	ELEVATOR	QT	QUANTITY
EMERG	EMERGENCY	QTY	QUANTITY
EQ	EQUAL	R	RADIUS OR RISER
EQUIP	EQUIPMENT	R	RESILIENT BASE
EWC	ELECTRICAL WATER COOLER	RB	REFLECTED CEILING PLAN
EXH	EXHAUST	RCP	ROOF DRAIN
EXIST	EXISTING	RD	REFERENCE
EXT	EXTERIOR	REF	REFERENCE
F	-----	REIN	REINFORCED / REINFORCING
FD	FLOOR DRAIN	REIN	REINFORCED / REINFORCING
FE	FIRE EXTINGUISHER	REQD	REQUIRED
FEC	FIRE EXTINGUISHER CABINET	REV	REVISION/REVISED
FF&E	FURNITURE, FINISHES, & EQUIPMENT	RM	ROOM
FFEL	FINISH FLOOR ELEVATION	RO	ROUGH OPENING
FHC	FIRE HOSE CABINET	RWL	RAIN WATER LEADER
FL	FLOOR	S	SOLID CORE
FND	FOUNDATION	SC	SCHEDULE
FO	FACE OF	SF	SQUARE FEET/FOOT
FP	FIRE PROTECTION	SIM	SIMILAR
FPG	FIRE PROOFING	SP	STANDPIPE
FRITW	FIRE RETARDANT TREATED WOOD	SPEC	SPECIFICATION
FT	FEET	SO	SQUARE
FURN	FURNITURE	SS	STAINLESS STEEL
FWC	FABRIC WALLCOVERING	STD	STANDARD
FWP	FABRIC WRAPPED PANEL	STL	STEEL
G	GROUND	STOR	STORAGE
G	-----	STRUCT	STRUCTURAL
GA	GAUGE / GAGE	T	TONGUE AND GROOVE
GALV	GALVANIZED	T&G	TREAD
GC	GENERAL CONTRACTOR	TC	TOP OF CURB
GFR	GLASS FIBER REINFORCED CONCRETE	TEL	TELEPHONE OR TELECOM
GFRG	GLASS FIBER REINFORCED GYPSUM	TO	TOP OF (SEE OTHER WORD)
GL	GLASS	TV	TELEVISION
GYPBD	GYPSUM WALLBOARD	TW	TOP OF WALL
H	-----	TYP	TYPICAL
HB	HOSE BIB	U	UNLESS OTHERWISE NOTED
HC	HOLLOW CORE	U.O.N.	UNLESS OTHERWISE NOTED
HCP	HANDICAPPED	V	VINYL COMPOSITION TILE
HOWD	HARDWOOD	VCT	VERTICAL
HOWR	HARDWARE	VEST	VESTIBULE
HM	HOLLOW METAL (STEEL FRAME)	VIF	VERIFY IN FIELD
HORIZ	HORIZONTAL	VT	VINYL TILE
HR	HOUR	VWC	VINYL WALL COVERING
HVAC	HEATING, VENTILATION, AIR CONDITIONING	W	WITHOUT
HW	HOT WATER	WC	WATER CLOSET
I	-----	WD	WOOD
ID	INSIDE DIAMETER	WP	WORK POINT
IN	INCH	WR	WATER RESISTENT/REPELLANT
INCL	INCLUDED / INCLUDING		
INSUL	INSULATION		
INT	INTERIOR		
INV	INVERT		
J	-----		

	ACOUSTICAL TILE		GLASS SECTION		SAND
	ALUMINUM		GRAVEL		SHINGLE
	CARPET		GYPSUM BOARD		STEEL
	DISTURBED EARTH		HOMOSITE		STONE
	UNDIST. EARTH		INSULATION - RIGID		WOOD
	EIFS		MASONRY - CONC. BLOCK		
	GLASS ELEVATION		PLYWOOD		

AEA_GRAPHICS LEGEND
 SCALE: 3" = 1'-0"

ABBREVIATIONS

SYMBOL LEGEND
 SCALE: 1/4" = 1'-0"

SHEET NO.	DRAWING TITLE
SW-1	TOPOGRAPHIC SURVEY
G1.01	GRAPHICS LEGEND, ABBREVIATIONS, SYMBOL LEGEND
G2.01	EGRESS PLAN - 1ST FLOOR, CODE INFORMATION
L0.00	OVERALL SITE PLAN
L1.00	SITE PLAN
D1.01	DEMOLITION PLAN - 1ST FLOOR
A1.01	CONSTRUCTION PLAN - 1ST FLOOR
A2.01	EXTERIOR ELEVATIONS
A2.02	EXTERIOR ELEVATIONS
A3.01	BUILDING SECTIONS
A4.01	PERSPECTIVE VIEWS
A9.01	FINISH PLAN - 1ST FLOOR
Grand total: 12	

DRAWING LIST

UNIVERSITY OF SAINT JOSEPH

RENOVATIONS & ADDITION TO LOURDES HALL

1678 ASYLUM AVENUE
WEST HARTFORD, CT 06117

CONSULTANTS

KEY PLAN

PROGRESS SET - NOT FOR CONSTRUCTION

PROJECT DATA

PROJECT NUMBER 15098
CURRENT SUBMISSION DATE 01.16.2016
DRAWN Author
CHECKED Checker
SCALE
FILE REFERENCE C:\Users\vh\Documents\15098-St. Joseph College Lourdes Hall Renovations-Central\2016-SD_Option2-Single-Roof_RHA.rvt

HISTORY OF SUBMISSIONS

No.	Date	Description
1	1.15.2016	REGULATORY SUBMISSION

SCHEMATIC DESIGN PRICING SET


SHEET TITLE

OVERALL SITE PLAN

L0.00.



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UNIVERSITY OF SAINT JOSEPH

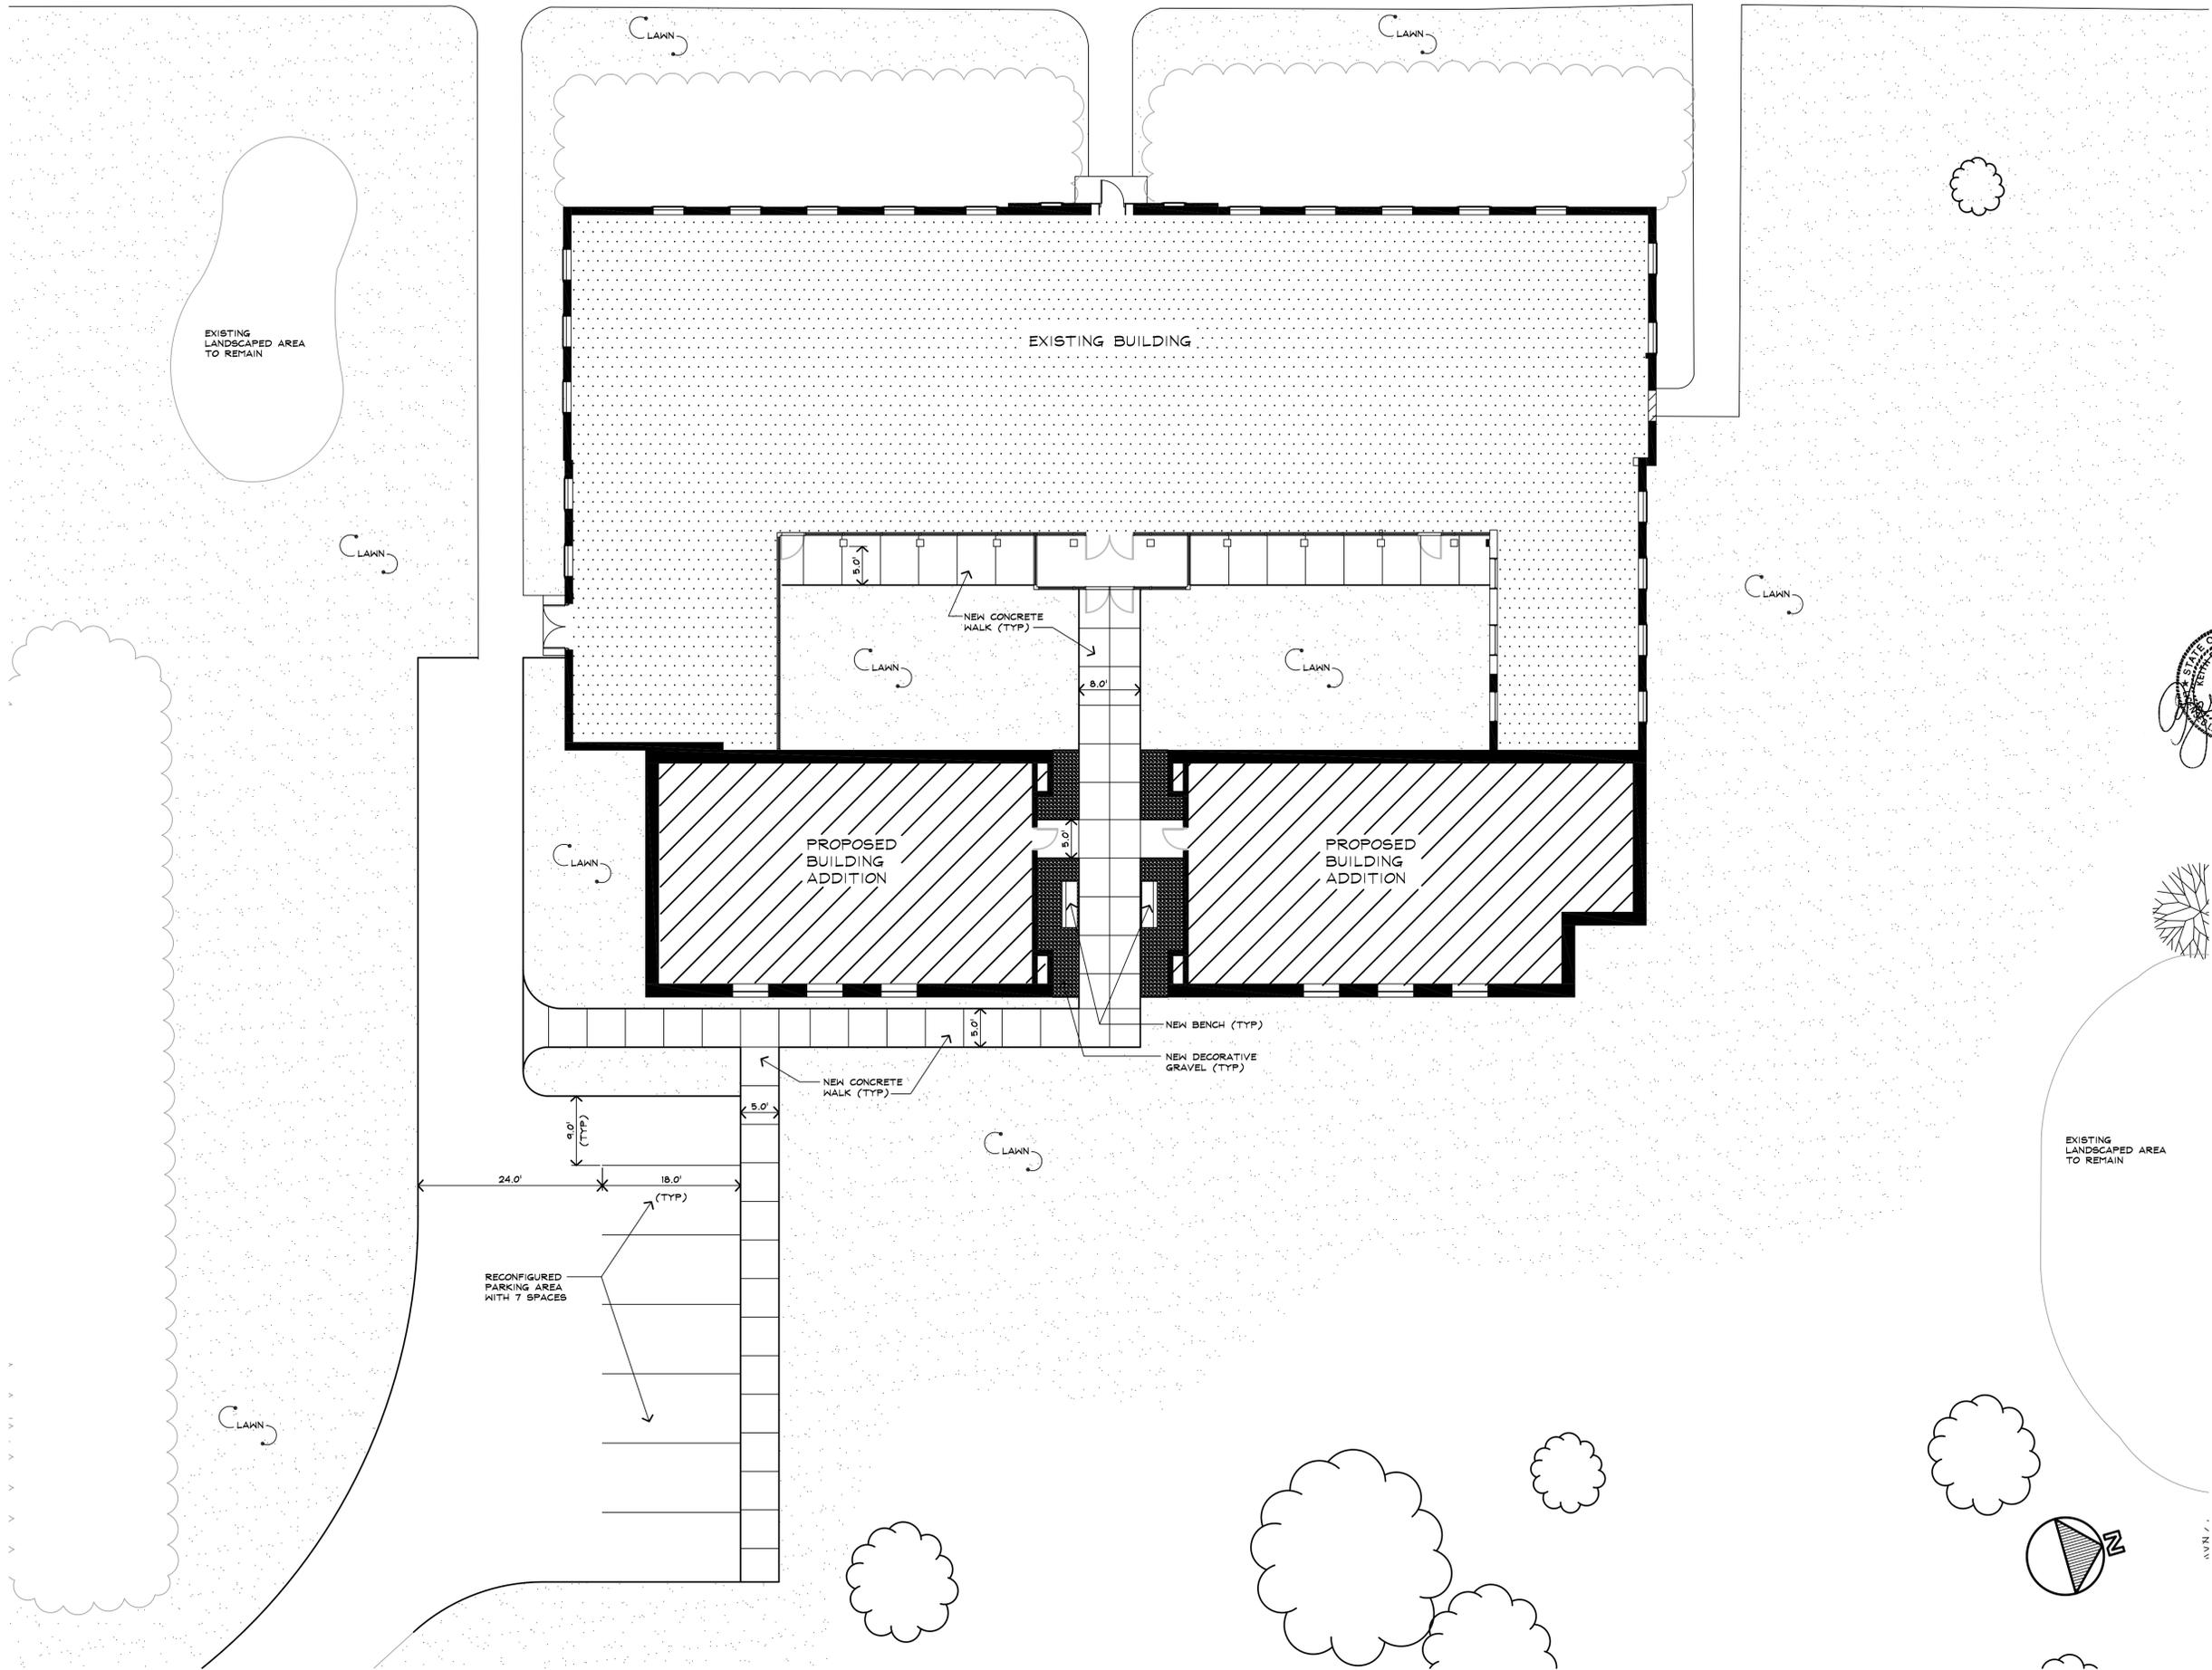RENOVATIONS & ADDITION TO LOURDES HALL

1678 ASYLUM AVENUE
WEST HARTFORD, CT 06117



KEY PLAN

PROGRESS SET - NOT FOR CONSTRUCTION

PROJECT DATA

PROJECT NUMBER	12040
CURRENT SUBMISSION DATE	01.15.2016
DRAWN	DC
CHECKED	KB
SCALE	1"=10'
FILE REFERENCE	C:\Users\jmb\Documents\15098-St. Joseph College Lourdes Hall Renovations-Central-2016-SD_Option2-Single-Roof_jmb.rvt

HISTORY OF SUBMISSIONS

No.	Date	Description
1	1.15.2016	REGULATORY SUBMISSION

REGULATORY SUBMISSION

SITE PLAN

L1.00

UNIVERSITY OF SAINT JOSEPH

RENOVATIONS & ADDITION TO LOURDES HALL

1678 ASYLUM AVENUE
WEST HARTFORD, CT 06117

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PROGRESS SET - NOT FOR CONSTRUCTION



PROJECT DATA

PROJECT NUMBER 15098
CURRENT SUBMISSION DATE 01.16.2016
DRAWN Author
CHECKED Checker
SCALE 1/8" = 1'-0"
FILE REFERENCE C:\Users\rha\Documents\15098-St. Joseph College Lourdes Hall
Renovations-Central 2016-SD_Option2-Single-Roof_RHA.rvt

HISTORY OF SUBMISSIONS


No.	Date	Description

SCHEMATIC DESIGN PRICING SET

SHEET TITLE

CONSTRUCTION PLAN - 1ST FLOOR

A1.01.

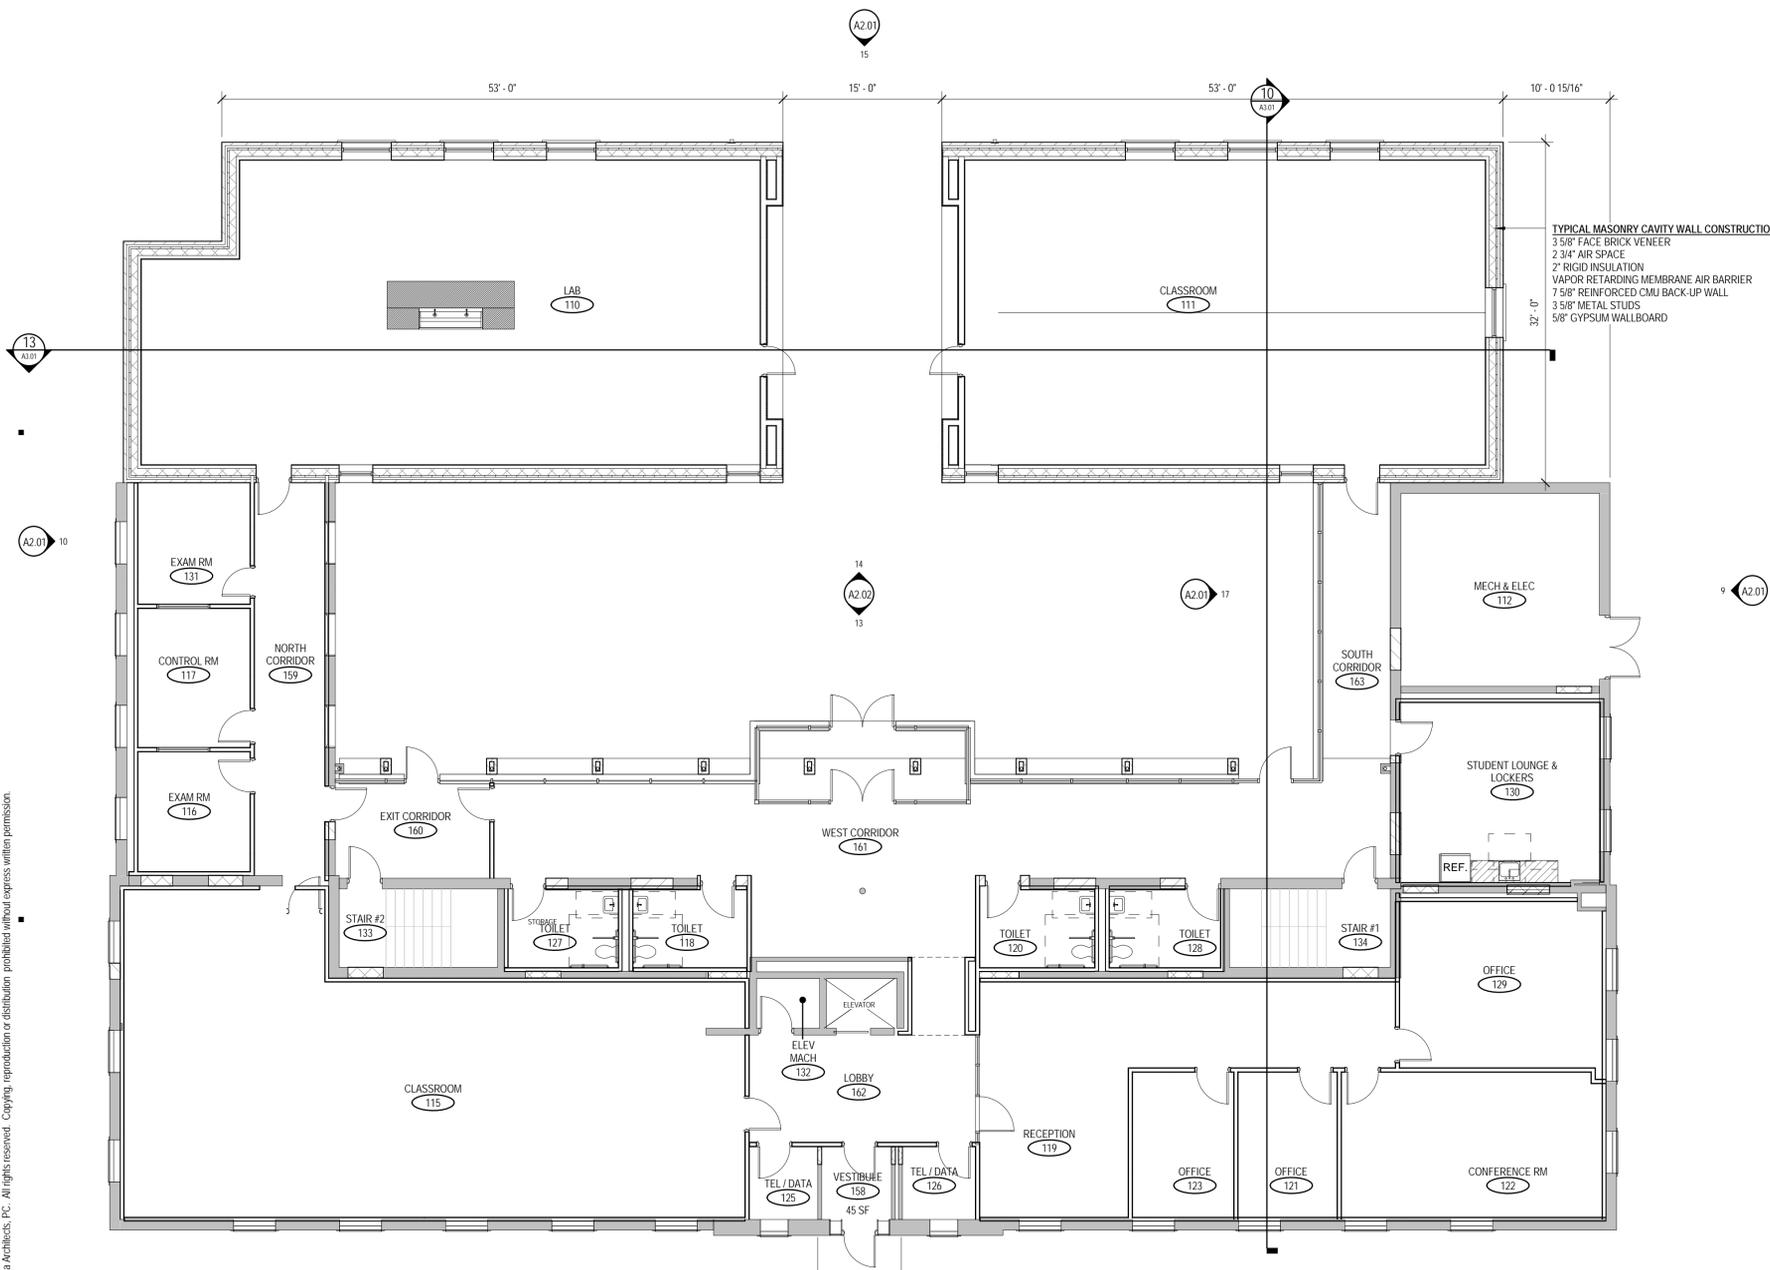


TYPICAL MASONRY CAVITY WALL CONSTRUCTION
 3 5/8" FACE BRICK VENEER
 2 3/4" AIR SPACE
 2" RIGID INSULATION
 VAPOR RETARDING MEMBRANE AIR BARRIER
 7 5/8" REINFORCED CMU BACK-UP WALL
 3 5/8" METAL STUDS
 5/8" GYPSUM WALLBOARD


GENERAL CONSTRUCTION PLAN NOTES	
1	ALL DIMENSIONS FROM FACE OF FINISH TO FACE OF FINISH UNLESS OTHERWISE INDICATED. ALL DIMENSIONS NOTED AS 'HOLD' ARE CRITICAL.
2	PROVIDE FIRE TREATED WOOD BLOCKING WITHIN NEW AND EXISTING WALLS AS REQUIRED FOR ANCHORING OF ALL BUILT-INS, SHELVING, CABINETS AND WALL MOUNTED ACCESSORIES. VERIFY LOCATIONS WITH ARCHITECT/OWNER.
3	PATCH ALL EXISTING WALLS WHERE REQUIRED TO CREATE SMOOTH SURFACE FOR PAINT FINISH.
4	ALL WORK SHALL FOLLOW ALL APPLICABLE CODES.
5	PREPARE EXISTING FLOOR SUBSTRATE AS REQUIRED FOR NEW FLOOR FINISH.
6	PROVIDE (2) 20 GA. METAL STUDS AT JAMBS OF ALL NEW DOOR OPENINGS.
7	ALL CONCEALED BLOCKING SHALL BE FIRE TREATED.
8	AT ANY EXISTING CONSTRUCTION TO RECEIVE WORK (RE: NEW DOOR, INFILL PARTITION, ETC.) G.C. TO PATCH EXISTING CONSTRUCTION AS REQUIRED TO MATCH EXISTING ADJACENT SURFACE.
9	DETAILS NOTED AS TYPICAL APPLY TO ALL SIMILAR LOCATIONS UNLESS OTHERWISE NOTED.
10	RELOCATE ALL STORED ITEMS WITHIN THE SCOPE OF WORK AREA TO A LOCATION WITHIN THIS BUILDING AS DIRECTED BY OWNER.
11	CONTRACTOR'S PRICE SHALL INCLUDE A COMPLETE CONSTRUCTION CLEAN-UP.
12	CONTRACTOR TO HAVE A "SHOP VAC" OR SIMILAR EQUIP. ON SITE TO KEEP SITE CLEAN DURING THE CONSTRUCTION PROCESS.
13	ALL WIRING, CONDUIT, RACEWAYS, ETC. SHALL BE CONCEALED WITHIN WALLS. G.C. TO PROVIDE CUTTING, PATCHING, PLASTER RINGS AND PULL STRINGS AS REQUIRED TO PROVIDE SUCH CONCEALMENT. PATCH AND PAINT ENTIRE WALL AFFECTED BY NEW WORK.
14	G.C. TO MAINTAIN CLEAR EGRESS PATHS AT ALL TIMES DURING CONSTRUCTION.
15	WHERE ANY TELEPHONE, DATA, & ELECTRICAL WIRING HAVE BEEN DEMOLISHED, PATCH WALL & FINISH AS SCHEDULED. WHERE ANY EXIST'G JUNCTION BOXES OR CONDUIT HAVE BEEN REMOVED, PATCH WALL & FINISH AS SCHEDULED UNLESS INDICATED OTHERWISE.
16	UNLESS INDICATED OTHERWISE, ALL NEW DOORS SHALL BE LOCATED 4" OFF FINISHED WALL. (4" TO INSIDE FACE OF FRAME)
17	CEILING HEIGHTS MAY NOT BE MODIFIED DUE TO ANY CONDITIONS NEW OR EXISTING. MODIFY EXISTING CONDITIONS AS REQUIRED TO MAINTAIN SCHEDULED CEILING HEIGHT.
18	CONTRACTOR SHALL BE RESPONSIBLE FOR VISITING THE SITE PRIOR TO BIDDING TO DETERMINE ALL EXIST'G CONDITIONS. CONTRACTOR IS RESPONSIBLE FOR VERIFYING EXTENT OF ALL DEMOLITION AND NEW WORK. G.C. SHALL VERIFY CONDITION OF EXIST'G WALLS TO REMAIN. G.C. SHALL VERIFY SCOPE OF THIS WORK BEFORE PRICING PROJECT. CONTRACTOR IS RESPONSIBLE FOR NOTIFYING THE ARCHITECT OF ANY DISCREPANCIES.

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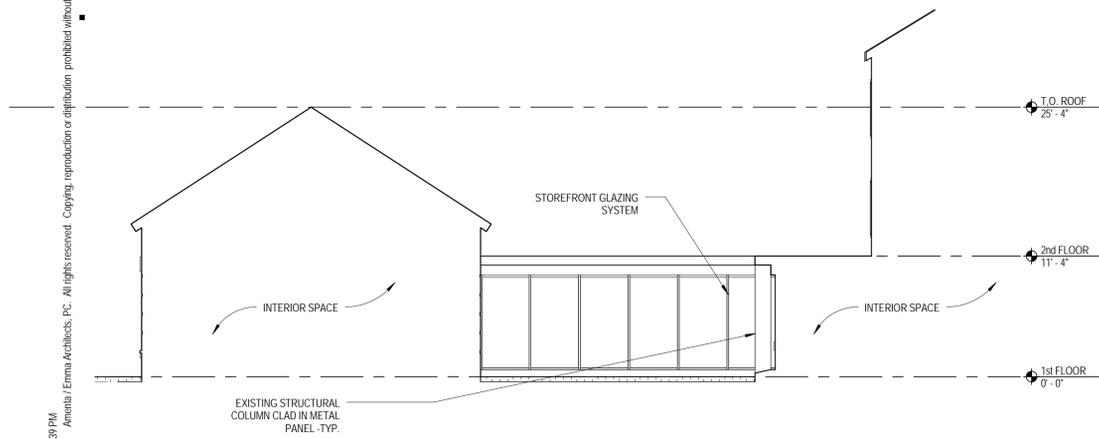
17 1ST FLOOR CONSTRUCTION PLAN
SCALE: 1/8" = 1'-0"

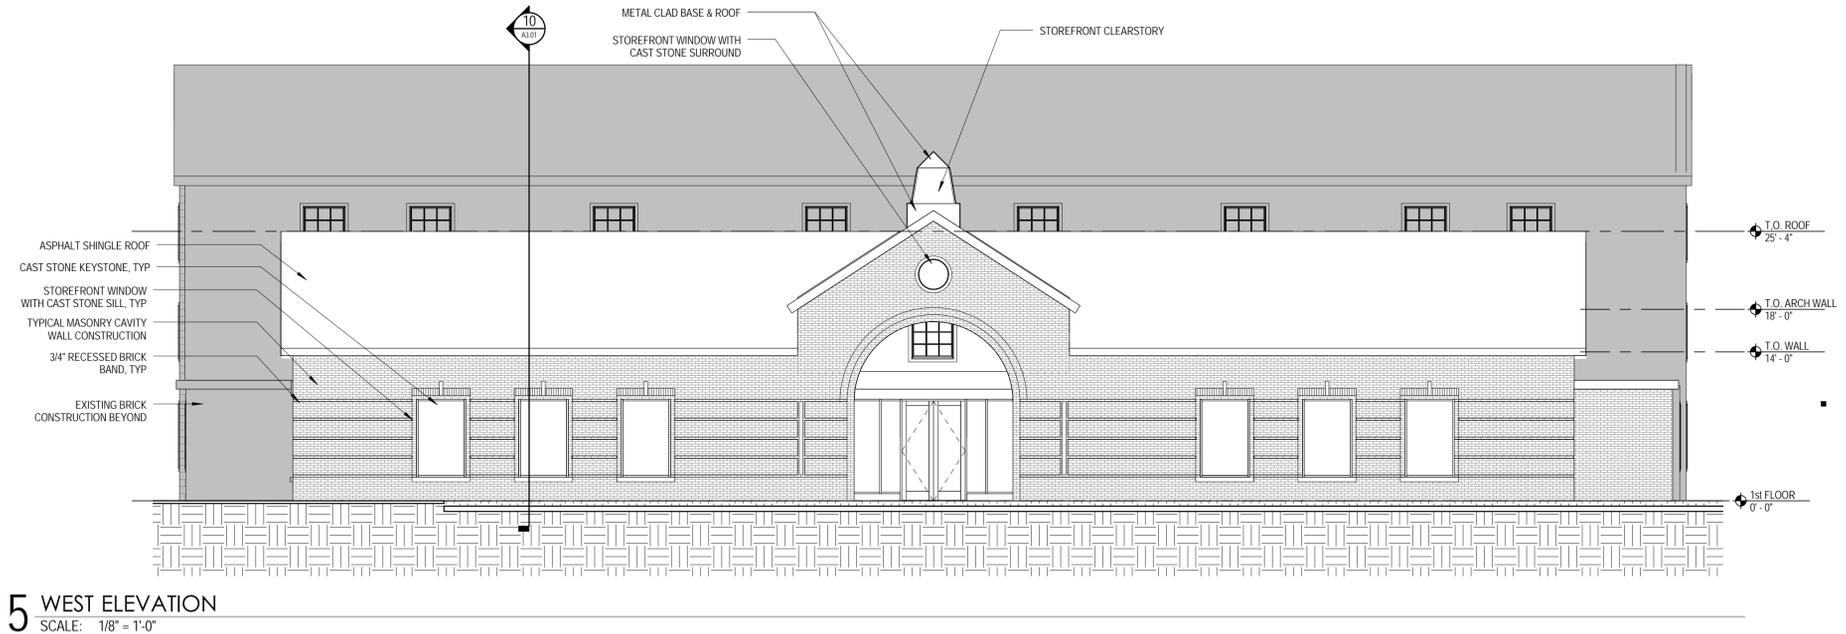

15 WEST ELEVATION
SCALE: 1/8" = 1'-0"

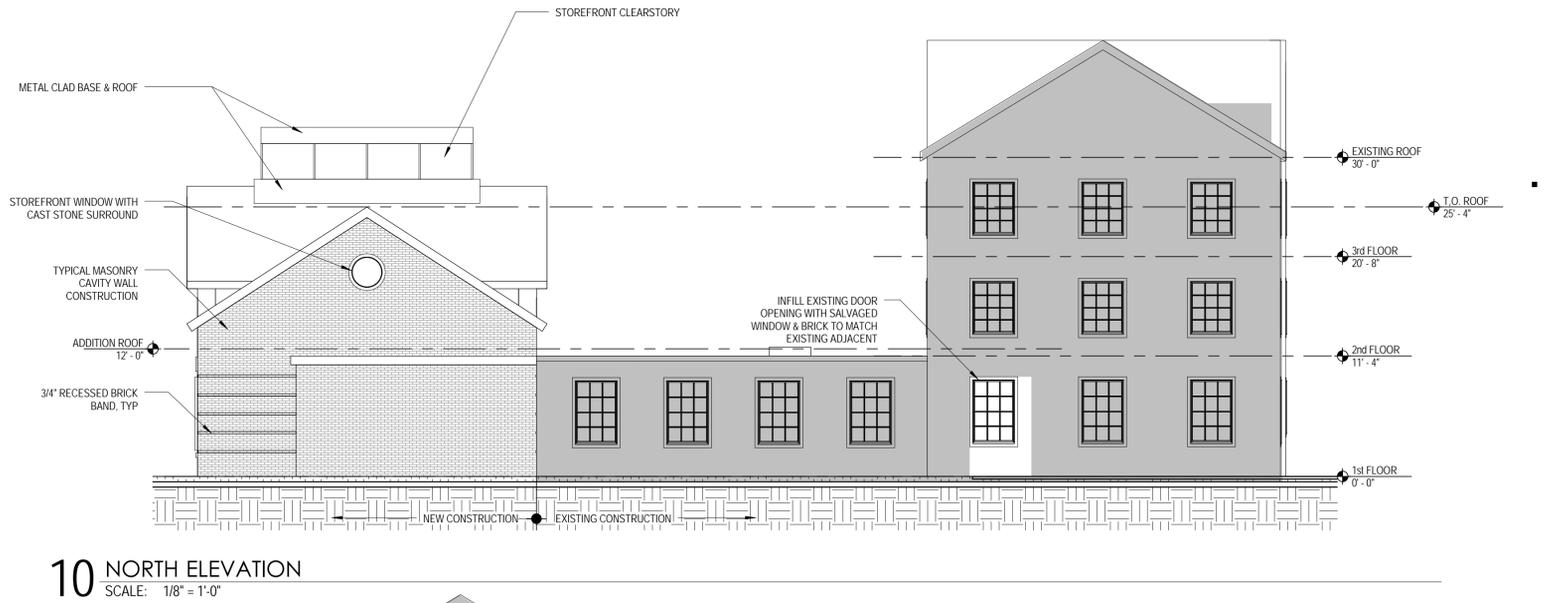

10 NORTH ELEVATION
SCALE: 1/8" = 1'-0"



17 NORTH ELEVATION - COURTYARD
SCALE: 1/8" = 1'-0"



9 SOUTH ELEVATION
SCALE: 1/8" = 1'-0"

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CHECKED	Checker
SCALE	1/8" = 1'-0"
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HISTORY OF SUBMISSIONS

No.	Date	Description

SCHEMATIC DESIGN PRICING SET

SHEET TITLE

EXTERIOR ELEVATIONS

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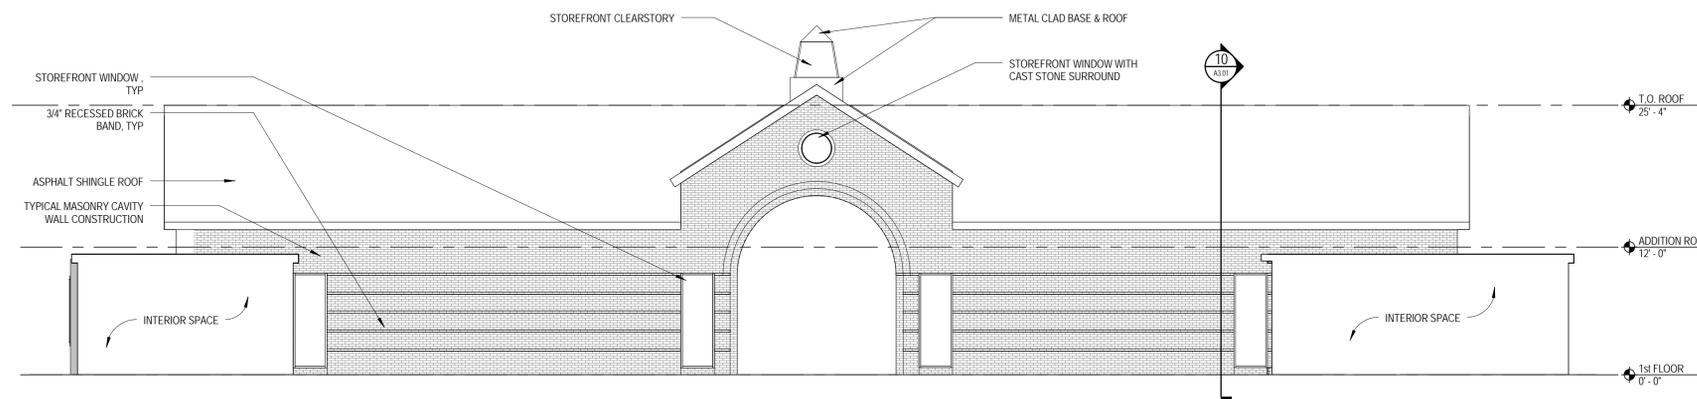
HISTORY OF SUBMISSIONS

No.	Date	Description

SCHEMATIC DESIGN PRICING SET

SHEET TITLE

EXTERIOR ELEVATIONS



14 WEST ELEVATION - COURTYARD
SCALE: 1/8" = 1'-0"



13 EAST ELEVATION - COURTYARD
SCALE: 1/8" = 1'-0"

UNIVERSITY OF SAINT JOSEPH

RENOVATIONS & ADDITION TO LOURDES HALL

1678 ASYLUM AVENUE
WEST HARTFORD, CT 06117

CONSULTANTS

KEY PLAN

PROGRESS SET - NOT FOR CONSTRUCTION



PROJECT DATA

PROJECT NUMBER 15098
 CURRENT SUBMISSION DATE 01.16.2016
 DRAWN Author
 CHECKED Checker
 SCALE 1/8" = 1'-0"
 FILE REFERENCE C:\Users\vhaj\Documents\15098-St. Joseph College Lourdes Hall Renovations-Central 2016-SD_Option2-Single-Roof_RHA.rvt


HISTORY OF SUBMISSIONS

No.	Date	Description

SCHEMATIC DESIGN
PRICING SET

SHEET TITLE

BUILDING SECTIONS

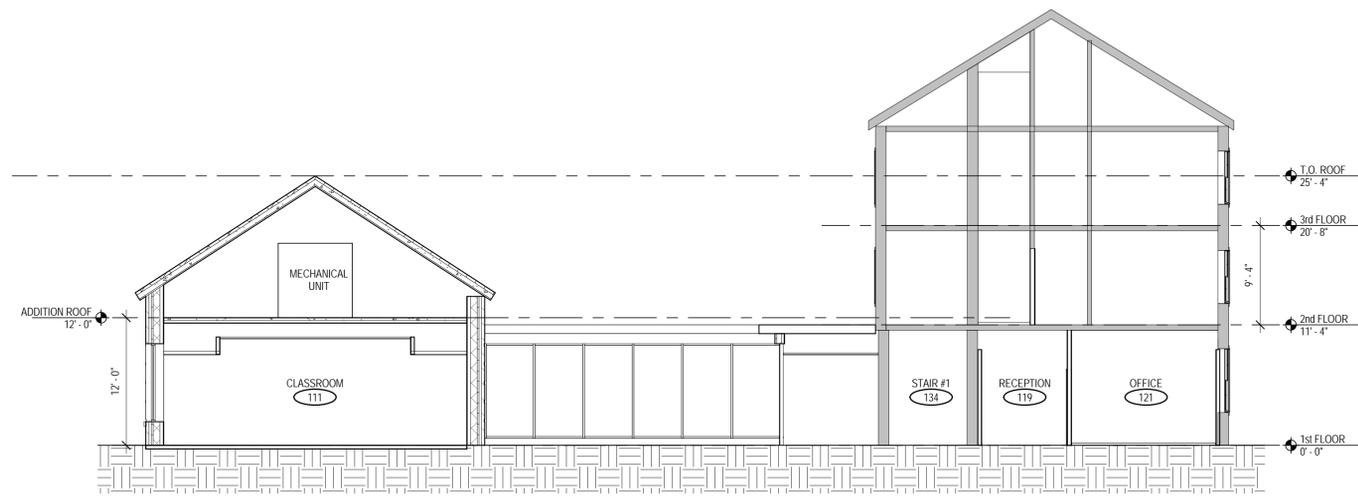

10 EAST / WEST BUILDING SECTION
SCALE: 1/8" = 1'-0"



13 NORTH / SOUTH BUILDING SECTION
SCALE: 1/8" = 1'-0"

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PERSPECTIVE VIEWS

